

PROPOSED

NO CHANGE

NO CHANGE

NO CHANGE

NO CHANGE

22.6 FT.

NO CHANGE

(2,048 SQ. FT.)

102.1 FT. NO CHANGE

201.7 FT.

75.02 FT.

24.8 FT.

12.2 FT.

5.40 %

(1,453 SQ. FT.)

MAX. STORIES 2 1/2 STORIES 2 1/2 STORIES NO CHANGE

ADDITIONAL DEFINITIONS AND ORDINANCES FOR REFERENCE

ACCESSORY USE

BUILDING

GARAGE

BUILDING AREA

https://ecode360.com/36915264

THE LOT WIDTH SHALL BE MEASURED AT THE FRONT YARD SETBACK LINE.

THE AVERAGE HORIZONTAL DISTANCE BETWEEN FRONT AND REAR LOT LINES, MEASURED IN THE GENERAL DIRECTION OF ITS SIDE LOT LINES. IN THE CASE OF AN

IRREGULARLY SHAPED LOT WHICH COMES TO A POINT IN THE REAR, THE LOT DEPTH SHALL BE THE DISTANCE OF THE PERPENDICULAR LINE EXTENDING FROM THE CENTER

OF THE REAR LOT LINE TO THE STREET.

SHALL BE THE SAME AS LOT WIDTH EXCEPT IN THE CASE OF FLAG LOTS WHERE IT SHALL

BE A MINIMUM OF 50 FEET.

* FOR LOTS AROUND THE BULB OF A CUL-DE-SAC LOT FRONTAGE SHALL BE AT LEAST

50% OF THE LOT WIDTH

AN OPEN, UNOCCUPIED SPACE ON THE SAME LOT WITH THE BUILDING, EXTENDING THE

FULL WIDTH OF THE LOT AND SITUATED BETWEEN THE STREET LINE AND THE FRONT

LINE OF THE BUILDING PROJECTED TO THE SIDE LINES OF THAT LOT. A YARD EXTENDING ACROSS THE FULL WIDTH OF THE LOT AND LYING BETWEEN THE

REAR LINE OF THE LOT AND THE NEAREST LINE OF ANY BUILDING. THE DEPTH OF A REAR

YARD SHALL BE MEASURED AT RIGHT ANGLES TO THE REAR LINE OF THE LOT OR, IF THE LOT IS NOT RECTANGULAR, THEN IN THE GENERAL DIRECTION OF ITS SIDE LOT LINES.

AN OPEN, UNOCCUPIED SPACE BETWEEN THE SIDE LINE OF THE LOT AND THE NEAREST POINT OF THE BUILDING AND EXTENDING FROM THE FRONT YARD TO THE REAR YARD

OR, IN ABSENCE OF EITHER OF SUCH YARDS, TO THE STREET OR REAR LOT LINE, AS THE

CASE MAY BE. THE WIDTH OF A SIDE YARD SHALL BE MEASURED AT RIGHT ANGLES TO THE SIDE LINES OF THE LOT.

THAT PART OF ANY BUILDING, NOT INCLUDING BASEMENTS, COMPRISED BETWEEN THE LEVEL OF ONE FINISHED FLOOR AND THE LEVEL OF THE NEXT HIGHER FINISHED FLOOR

OR, IF THERE IS NO HIGHER FINISHED FLOOR, THEN THAT PART OF THE BUILDING

COMPRISED BETWEEN THE LEVEL OF THE HIGHEST FINISHED FLOOR AND THE TOP OF

THE ROOF BEAMS.

THE VERTICAL DISTANCE OF A STRUCTURE DERIVED FROM THE AVERAGE FINISHED

GRADE AT THE FOUNDATION CORNERS OF THE BUILDING OR STRUCTURE, INCLUDING

ADDITIONAL MEASUREMENTS AT THE CENTER OF ALL EXTERIOR SIDE, FRONT AND REAR

BUILDING WALLS, TO THE HIGHEST POINT OF THE BUILDING OR STRUCTURE, EXCLUDING

A CHIMNEY OR OTHER SIMILAR STRUCTURES.

THE AREA COVERED BY ALL BUILDINGS ON A LOT, EXPRESSED AS A PERCENTAGE OF THE TOTAL LOT AREA.

THE PORTION OF A LOT COVERED BY ALL BUILDINGS, ASPHALT OR CONCRETE PAVING,

A BUILDING OR USE SUBORDINATE IN AREA, EXTENT AND PURPOSE TO THE PRINCIPAL BUILDING OR USE ON A LOT AND USED FOR PURPOSES CUSTOMARILY INCIDENTAL TO THOSE OF THE PRINCIPAL BUILDING.

ANY TEMPORARY OR PERMANENT STRUCTURE HAVING A ROOF SUPPORTED BY COLUMNS, PIERS, OR WALLS AND INTENDED FOR THE SHELTER, HOUSING OR ENCLOSURE OF ANY INDIVIDUAL, ANIMAL, PROCESS, EQUIPMENT, GOODS OR MATERIALS OF ANY KIND. "BUILDING" SHALL ALSO BE ANY UNROOFED PLATFORM. "BUILDING" SHALL

ALSO INCLUDE RECEIVING AND TRANSMITTING RADIO, TELEVISION AND OTHER COMMUNICATIONS EQUIPMENT ANTENNAS, EXCEPT FOR SUCH ANTENNAS INSTALLED ON

THE ROOF OF A BUILDING AND EXTENDING NO MORE THAN 15 FEET ABOVE THE HIGHEST

LEVEL OF THE ROOF OF SUCH BUILDING.

A BUILDING ACCESSORY TO THE PRINCIPAL USE ON A LOT FOR THE STORAGE OF MOTOR

VEHICLES, EITHER FOR OR WITHOUT COMPENSATION. A BUILDING IN WHICH IS CONDUCTED THE MAIN OR PRINCIPAL USE OF THE LOT ON

WHICH THE BUILDING IS LOCATED.

https://ecode360.com/PE0939/laws/LF1454822.pdf

13.55 % 24.37 % PAVER STONE, TILE OR BLOCK, SIDEWALKS, SWIMMING POOL, PORCHES AND EXTERIOR STAIRS OR OTHER IMPERVIOUS SURFACES WHICH PREVENT WATER ABSORPTION TO

EXISTING

EXISTING

EXISTING

EXISTING

VARIANCE

VARIANCE

EXISTING

MIN. LOT AREA 15,000 SQ. FT. 26,892 SQ. FT. NO CHANGE

100 FT.

175 FT.

40 FT.

MIN. LOT WIDTH

MIN. LOT DEPTH

FRONTAGE

MIN. FRONT

YARD SETBACK

MIN. REAR YARD


SETBACK

MIN. ONE SIDE

MAX. BUILDING

COVERAGE

YARD SETBACK

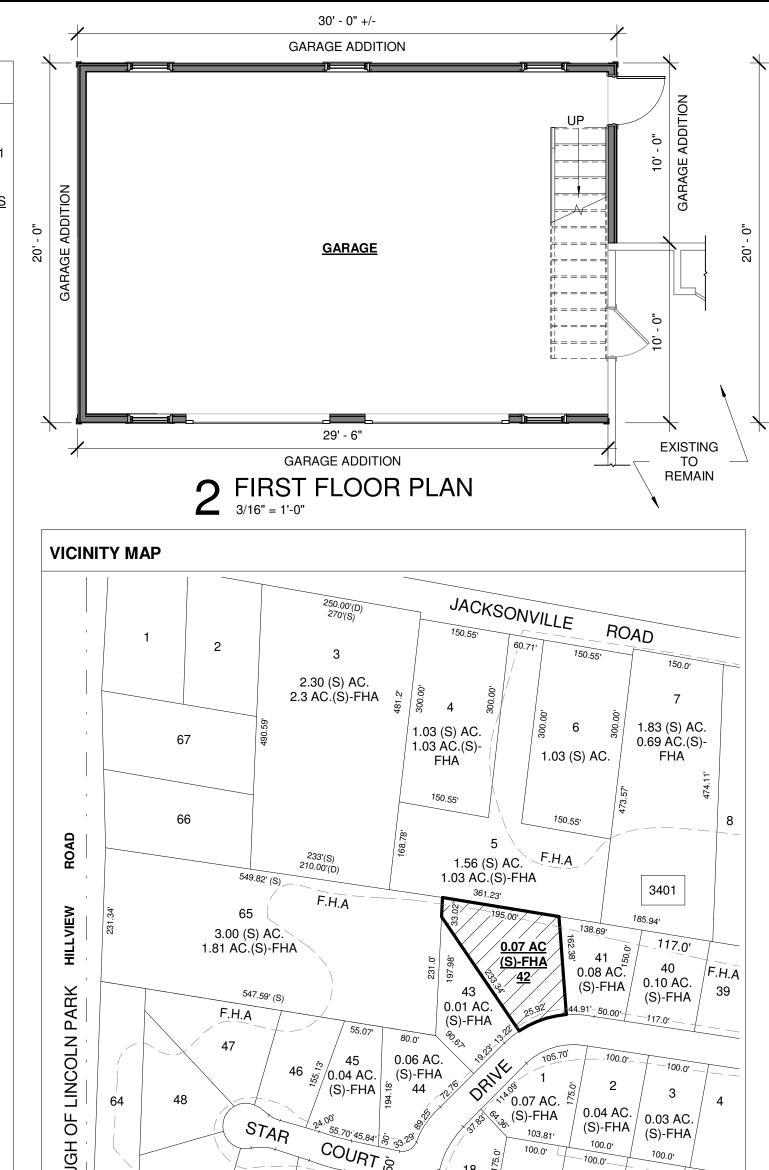

AR COURT & 100.0' 100.0	15 8 3402 100.0'
NAME	AREA
SPLIT-LEVEL FRAME DWELLING. NO. 41	1453 SF
PAVING STONE WALK	154 SF
ASPHALT DRIVE	962 SF
PAVING STONE PATIO	832 SF
POOL CONC WALK & PAVING STONE WALK	706 SF
N GROUND POOL	633 SF
FRAME SHED	113 SF
FRAME SHED	285 SF
NEW GARAGE	595 SF
	333 01
NEW ASPHALT DRIVE	823 SF

PERCENTAGE. 24.37 %

BUILDING COVERAGE (GROSS)	
NAME	AREA
SPLIT-LEVEL FRAME DWELLING. NO. 41	1453 SF
NEW GARAGE	595 SF
	2048 SF

PERCENTAGE: 7.61 %


FLOOR AREA FIRST FLOOR	
NAME	AREA
EXISTING FIRST FLOOR	1453 SF
NEW GARAGE	595 SF
	2048 SF

LOT COVERAGE		
AREA		
1453 SF		
154 SF		
962 SF		
832 SF		
706 SF		
633 SF		
113 SF		
285 SF		
595 SF		
823 SF		

DEBCENTAGE:	24 27 %

FLOOR AREA FIRST FLOOR		
NAME	AREA	
EXISTING FIRST FLOOR	1453 SF	
NEW GARAGE	595 SF	
	2048 SF	

FLOOR AREA SECOND FLOOR		
NAME	AREA	
EXISITNG SECOND FLOOR	966 SF	
NEW PLAY ROOM	595 SF	
	1561 SF	

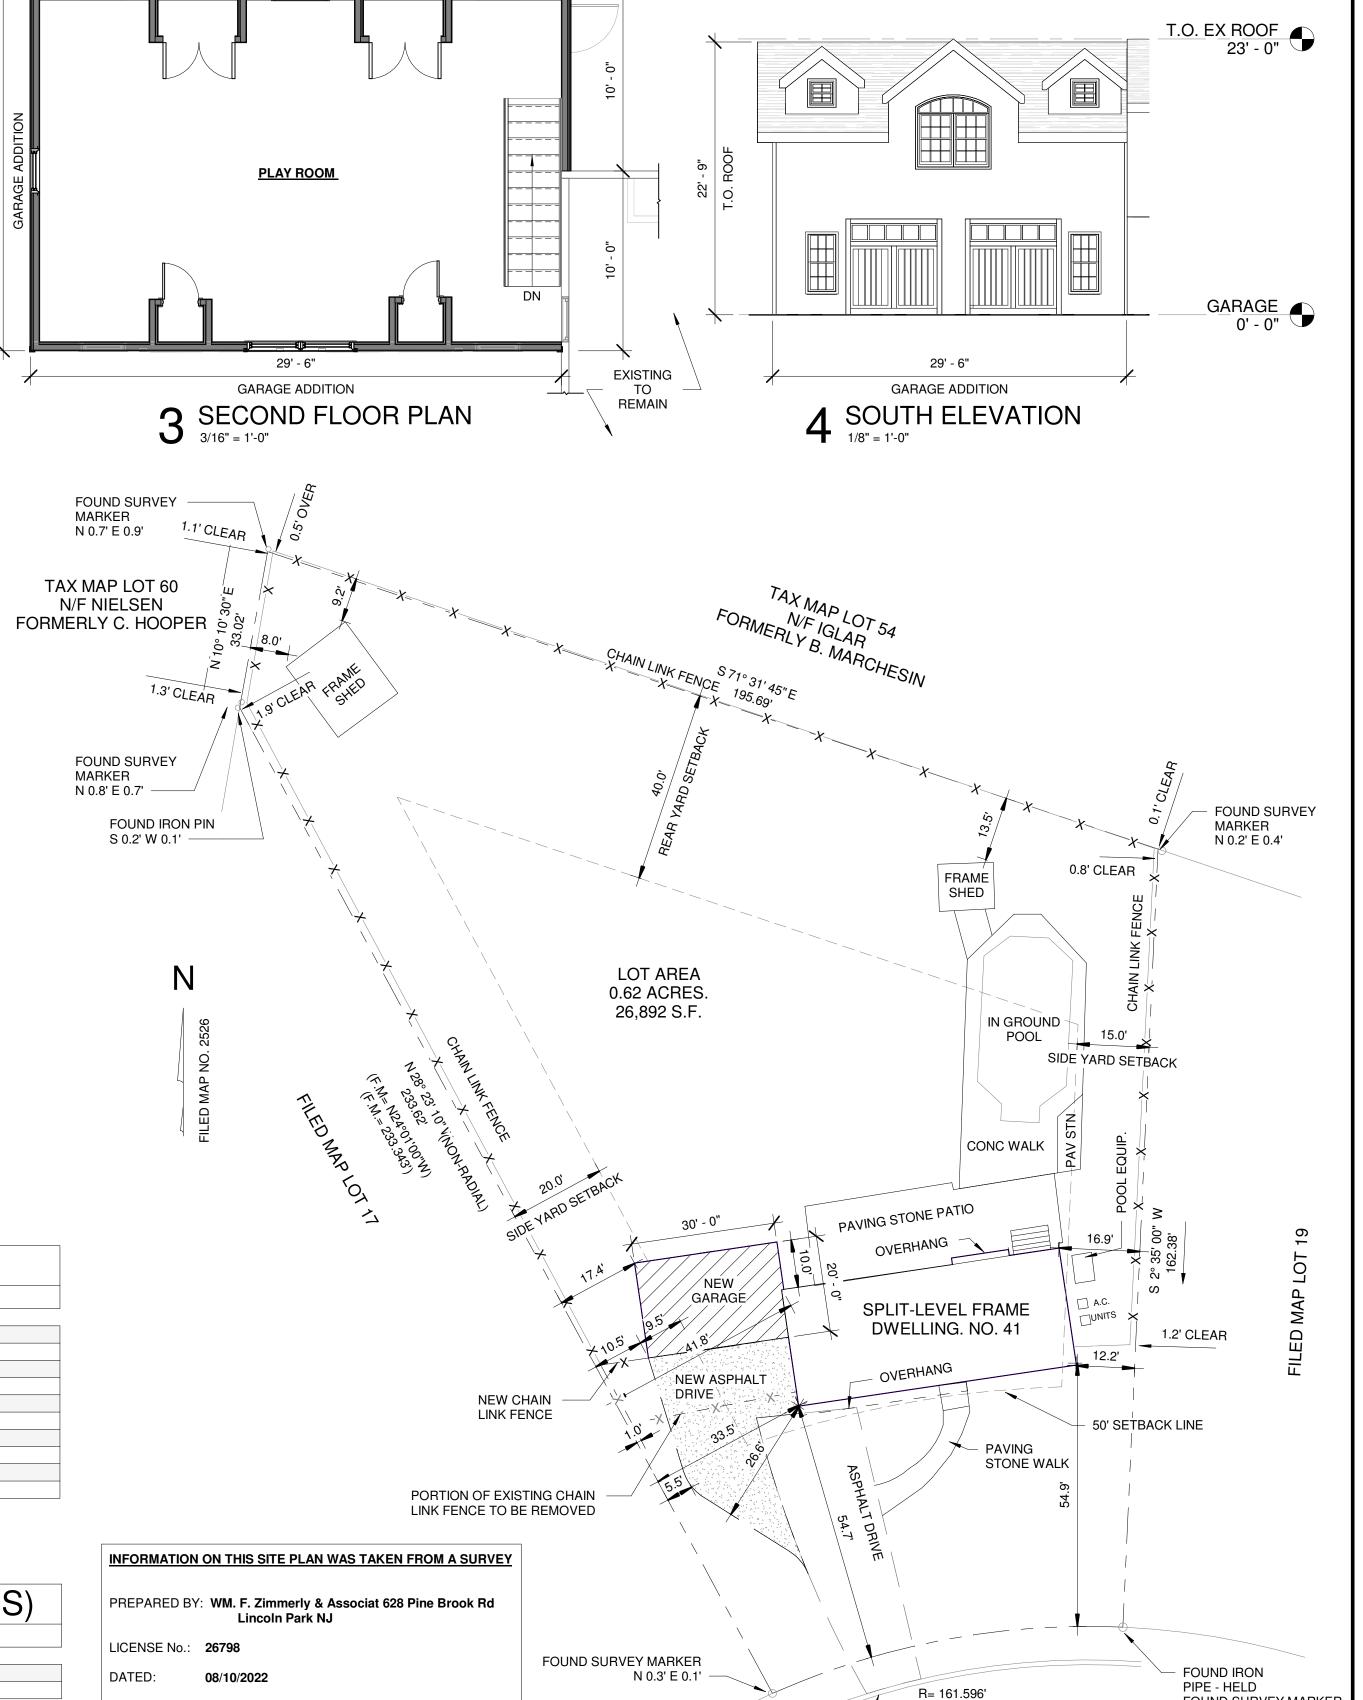

DESC. P.O.B

PLOT PLAN1" = 20'-0"

30' - 0" +/-

GARAGE ADDITION



new jersey • new york • connecticut • pennsylvania massachusetts • new hampshire • georgia

CLIENT

GREG MITROS

41 COLFAX AVENUE PEQUANNOCK, NJ 07440

PROJECT

MITROS RESIDENCE

41 COLFAX AVENUE PEQUANNOCK, NJ 07440 BLOCK 3401 LOT 42

BY SUBMITTING A BID, THE CONTRACTOR(S) ASSERTS THAT THE WORK SITE AND THESE DOCUMENTS HAVE BEEN THOROUGHLY EXAMINED AND THE WORK SCOPE IS FULLY UNDERSTOOD.

NO.	DATE	ISSUE / REVISION	ВҮ	CHECK
Α	2022.06.29	TOWNSHIP APPROVAL	ZS	KL
В	2022.08.24	UPDATED PLOT PLAN	ZS	KL

ARCHITECT OF RECORD KEITH H. LESSER AIA, LEED LIC. # NJ AI-10830 636 Jones Road Englewood, NJ 07631 201.519.7500

FOUND SURVEY MARKER

N 0.2' E 0.1'

APPLICANT/OWNERS: GREGORY F. & LORI M. MITROS

CHAIRMAN

SECRETARY

41 COLFAX DRIVE

(973) 769-2272

APPROVALS:

PEQUANNOCK, NJ 07440

A= 75.022'

PROJECT NUMBER:	DRAWING SCALE: AS NOTED
SEAL	DRAWING TITLE: SITE PLAN & FIRST FLOOR PLAN
	DRAWING NUMBER: